REQUEST FOR QUALIFICATIONS (RFQ) FOR PHASE III ENGINEERING SERVICES N. STATE STREET RESURFACING

VILLAGE OF HAMPSHIRE, IL DATE PUBLISHED: JANUARY 21, 2025

The Village of Hampshire is seeking a qualified Consulting Engineering Firm to perform construction engineering services for the Village's N. State Street Resurfacing project.

The Consulting Engineer shall perform and carry out, in a professional and satisfactory manner, the necessary services to complete the requirements included in this project. Currently, the Village anticipates construction for this work starting in August of 2025 and construction being completed by the end of September.

The services to be provided are described in the Minimum Scope of Services section of this proposal. All work must adhere to Village of Hampshire and Illinois Department of Transportation (IDOT) standards as required. In addition, this project will be funded using Federal Surface Transportation Program (STP) funding; therefore, all construction and construction engineering must meet Federal and IDOT standards.

This project includes the milling and resurfacing of FAU 0098 (N. State Street) from Hampshire Creek to Allen Road. The total length of this project is 1,864 feet (0.353 miles). Other improvements include pavement patching, combination concrete curb and gutter removal and replacement, structure adjustments, pavement markings and all other appurtenant work required to complete the project.

FUNDING:

The Phase III portion of this project is funded by Federal and local sources. The selection of the consultant will follow the Qualifications Based Selection (QBS) process in accordance with Section 5-5 of the Bureau of Local Roads and Streets (BLRS) Manual.

MINIMUM SCOPE OF SERVICES

The consultant shall provide the resident engineer, inspectors, professional testing services and other technical personnel necessary to review, observe, monitor and document the contractor's progress on the project from the start of field operations to the final completion. All work is to be performed according to the general industry engineering standards established by IDOT.

The consultant and sub-consultants are expected to complete construction inspection services in accordance with, but not limited to, the following general tasks:

Preconstruction Tasks

1. Attend an IDOT preconstruction meeting with all interested parties to discuss goals, objectives, and issues.

- 2. Conduct a local preconstruction meeting with all interested parties to discuss goals, objectives, and issues that the Village may have. Meeting minutes shall be submitted to the Village for review and approval.
- 3. Review the plans and specifications in depth, verifying quantities, elevations, and dimensions relevant to the project. Also, anticipate any potential conflicts or issues and develop solutions prior to construction.
- 4. Review the contractor's proposed construction schedule for compliance with the contract. Submittals should be included on this schedule, as well as all major subcontractors.
- 5. Set up field books, quantity books, diary, job box and all other forms of proper project documentation, including CMMS.
- 6. Prepare a project contact list with names, addresses, phone numbers and fax numbers for all contractors, subcontractors and suppliers for the project. Also, submit 24-hour contact numbers for all applicable parties.

Construction Tasks

- 1. Provide a resident engineer for required daily activities, such as: observing the progress and quality of work and determining if the work is proceeding in accordance with the contract documents. Maintain a site presence at all times when the contractor is working. Disapprove any work failing to conform to the contract documents and immediately inform Village and IDOT representatives. Verify that there are no deviations from the contract documents unless authorized by Village and IDOT representatives.
- 2. Keep inspector's daily reports and quantity book records up to date. Also maintain project diary noting all necessary observations. Advise if the contractor is falling behind schedule. Submit weekly reports from CMMS to IDOT and the Village.
- 3. Maintain orderly files of all relevant project documents so that they can be easily accessed.
- 4. Perform quantity measurements to prepare pay estimates and change orders to review with contractor and submit to Village for review and submittal to IDOT.
- 5. Provide liaison functions related to the coordination of contractors, utilities, developers, other agencies and property owners engaged or affected by the project.
- 6. Check and approve project submittals for compliance with standards. Forward recommendations to the Village and IDOT representatives.
- 7. Maintain daily contact with contractor to monitor schedule and recommend actions that should be taken if falling behind.
- 8. Maintain daily contact with the Village and IDOT representatives to inform on all relevant project information.
- 9. Inspect, document and inform the contractor and the Village of the adequacy of the establishment and maintenance of traffic control. Perform all necessary traffic control checks. Document all deficiencies and contractor responses to notices of the same. Inform the Village and IDOT of deficiencies and if the contractor does not correct or enforce as contract stipulates.
- 10. Provide construction layout as needed.
- 11. Provide Quality Assurance (QA) services in accordance with IDOT QC/QA practices and procedures (contractor will provide QC). Provide necessary coordination and qualified personnel to perform work for all materials. Obtain and test soil, asphalt, concrete and

aggregate samples to perform necessary testing to fulfill QA/geotechnical requirements. Reports shall be prepared in a timely manner and coordinated with QC data. The consultant shall fulfill the requirements as the QA manager.

- 12. Prepare minutes for all meetings and distribute to appropriate parties.
- 13. Maintain a set of working drawings as construction is progressing.
- 14. Provide all necessary equipment, instruments, supplies, transportation and personnel required to perform duties of the project team.
- 15. Maintain and periodically transmit to contractor a running punch list to expedite project close out.
- 16. Obtain material acceptance certifications as materials are incorporated into the project to expedite project closeout. Withhold payment until material inspection and certifications are provided.
- 17. Provide the Village with regular invoicing and provide supporting documentation as requested in order for the Village to submit for reimbursement in accordance with Section 5-10 of the Bureau of Local Roads and Streets Manual.

Post Construction Tasks

- Perform final inspection with the Village, the IDOT representative, contractor and all applicable utilities to finalize punch list. Document the items in the final punch list and submit them to the contractor for close out. Verify completion of all work and provide a recommendation to the Village.
- 2. Complete a contractor performance evaluation and conduct a post construction meeting with all interested parties to discuss lessons learned and identify steps to eliminate problems in the future.
- 3. Verify that all documentation is accomplished and that all material inspections and certifications have been accounted for and are complete.
- 4. Provide all documentation associated with the final balancing change order and final pay estimate.
- 5. Complete job box and conduct all audit(s) with IDOT. The job box will remain property of the Village.
- 6. Close out project with IDOT within a reasonable time frame after all construction is completed.

SUBMITTAL REQUIREMENTS

Please submit two (2) hard copies and one (1) digital copy of your firm's qualifications for services by 12:00 PM Friday, February 14, 2025. The digital copy should be in PDF format on a flash drive. Questions related to this RFQ should be submitted by email to Jay Hedges: jhedges@hampshireil.org. All questions must be received by 4:00 PM on Friday, February 7, 2025. The Village will provide the final response to all consultants by 4:00 PM on Tuesday, February 11, 2025.

The statement of qualifications (SOQ) should be mailed or hand delivered in a sealed envelope marked "Village of Hampshire – N. State Street Resurfacing - Construction Engineering Services SOQ" to Jay Hedges, Village Manager, 234 S. State Street Hampshire, IL 60140

All submittals must be thorough, complete and accurate. A table of contents and sectional tabs should be provided for all submittals.

Submittals shall include:

1. Firm Information

A title page that includes the following information: name of firm, local address, telephone number, fax number, name of contact person, location of branch offices, if any, and states in which your firm is licensed to practice. Additional general firm information can be provided but is limited to four pages (single sided).

IDOT Pre-Qualifications

As a prequalification of submittal, all prime consultants must be pre-qualified by IDOT and must submit documentation of their current prequalification status for the following:

- Highways Roads and Streets
- Special Services Construction Inspection

3. Sub-Consultants

List sub-consultants, if any, that will be used. Provide a copy of the firm's current prequalification status with IDOT.

4. Project Team

Provide biographical data and experience on key professional members of the firm(s) who could be directly involved with this particular project. Each resume should be limited to two pages (single sided). The key personnel should include the following:

- Project Manager who will be responsible for coordinating all activities. Must be a Licensed Professional Engineer in the State of Illinois with Phase III experience. Maximum one (1) person listed.
- Resident Engineer who will be responsible for overseeing all construction engineering activities (must be a Licensed Professional Engineer in the State of Illinois and have a current certificate for IDOT's "Documentation of Contract Quantities").

- Construction Engineer(s) who will be responsible for assisting the Resident Engineer and have a current certificate for IDOT's "Documentation of Contract Quantities".
- Any sub-consultants that will be part of the project team
- Any additional staff that will be involved in Federally funded projects. Maximum one (1) person listed.

5. Similar Project Experience

Provide a minimum of three recent examples of projects within the last five years that were federally funded or similar in nature to this project. Include a description of each project, including location, client, and scope of professional services delivered by your firm and the project team that staffed the project (project manager, resident engineer, inspector(s), etc.), duration of the project, and project cost. Project experience is limited to three pages (single sided).

CRITERIA FOR REVIEW:

The selection criteria and weightings for project selection are indicated below:

- 1. Firm Experience (30%). The entity's general experience, stability and qualifications related to similar federally funded Phase III projects and locally funded projects of similar nature.
- 2. Staff Capabilities (30%). The education, experience and expertise of the entity's principals and key employees. Qualifications and experience of personnel to perform the required observation and inspection of project in accordance with general industry engineering standards established by IDOT.
- 3. Past Performance (30%). The entity's history of performance on projects similar to the one under consideration.
- 4. Local presence (10%). Knowledge of local community.


A selection committee comprised of staff from the Village will evaluate the SOQ's. The SOQ's will be reviewed, evaluated and scored, using the criteria and weights defined above. The selected consultant will be notified, and a final scope and hours will be negotiated. The engineering agreement will be Cost Plus Fixed Fee format using the BLR 05530 form. The selected consultant shall also submit draft BC 775 and BC 776 (if needed) forms for review with the draft BLR 05530.

The Village will begin reviewing the SOQ's on Tuesday, February 18, 2025. The Village intends to have negotiations completed and all of the draft forms (BLR 05530, BC 775, BC 776 (if needed)) submitted by Friday February 28, 2025.

The engineering agreement will not be presented to the Village Board until after the agreement is reviewed by IDOT. IDOT will review the engineering agreement to verify elements of the contract costs, acceptable indirect cost rate(s) for application to contracts and assuring consultant

IDOT review and eventual approval by the Village Board.

compliance with the Federal cost principles. Approval of the engineering agreement is subject to

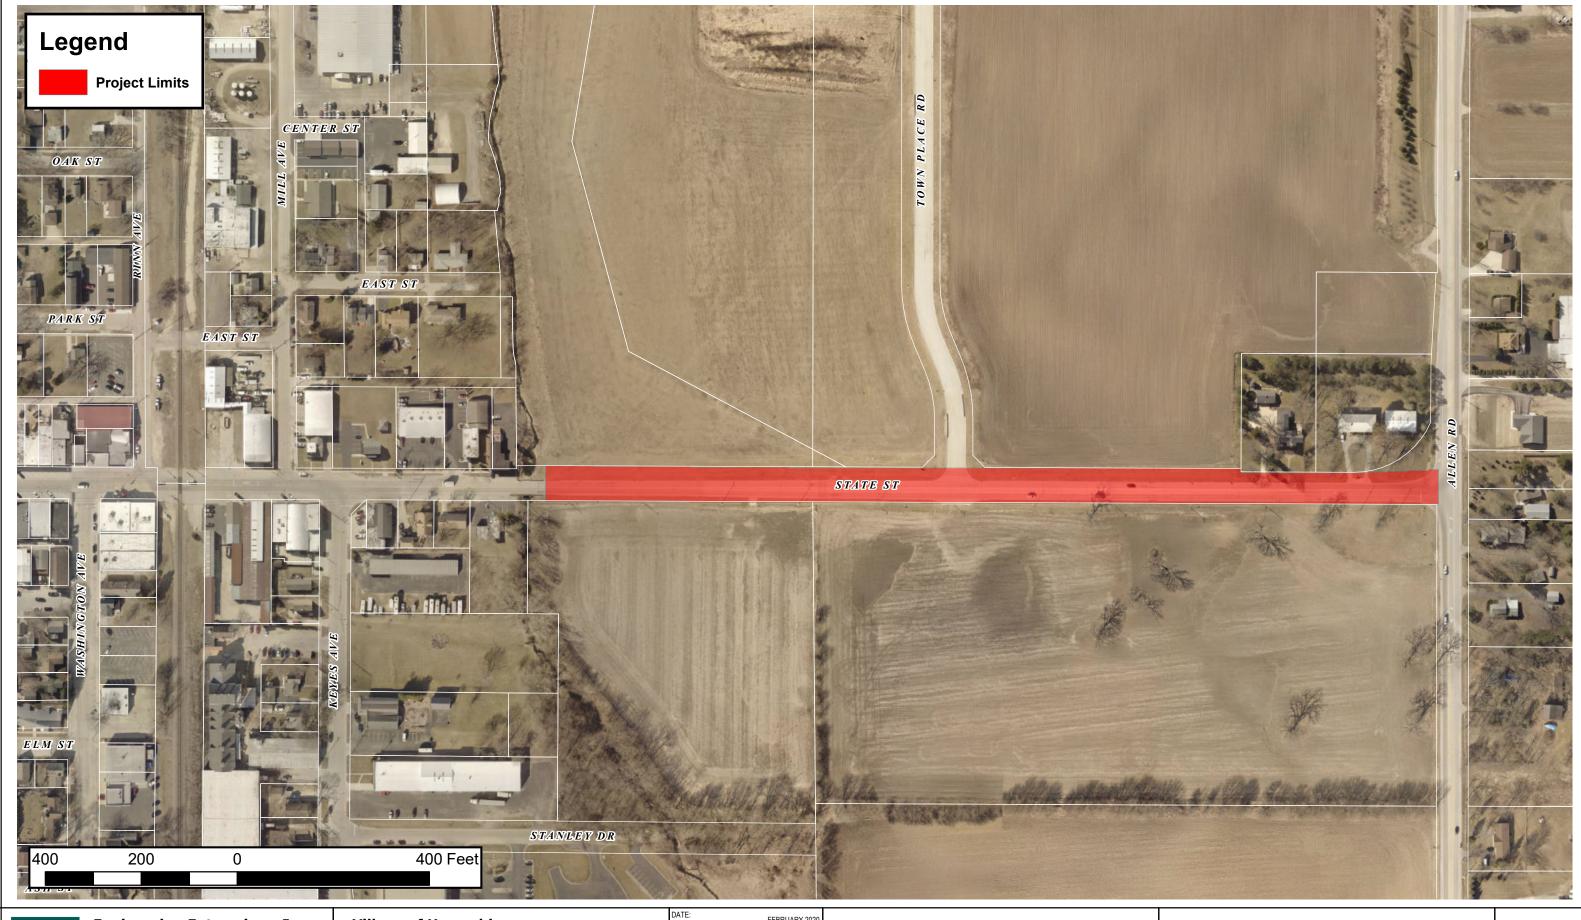



Engineering Enterprises, Inc.

52 Wheeler Road Sugar Grove, Illinois 60554 (630) 466-6700 www.eeiweb.com

Village of Hampshire234 S. State Street - P.O. Box 457
Hampshire, IL 60140-0457
(847) 683-2181 www.hampshireil.org

DATE:	FEBRUARY 2020
BY:	MJT
CHK:	
PATH:	H:\GIS\Public\Hampshire\2020\HA2000
FILE:	HA200 - French Rd & RT 72 (WM)

VILLAGE OF HAMPSHIRE, ILLINOIS

ATTACHMENT E NORTH STATE STREET LOCATION MAP



FOR INDEX OF SHEETS, HIGHWAY STANDARDS, AND PR LEGEND SEE SHEET NO. 2

STATE STREET

DESIGN DESIGNATION
MAJOR COLLECTOR
DESIGN SPEED = 45 M.P.H.
POSTED SPEED = 40 M.P.H.
ADT (2023) = 4000 VPD

100' 200' 300'— 1"= 100'
0 10' 20' 30' — 1"= 10'
0 50' 100'
1"= 50'
0 50' 100'
1"= 40'
0 50' 100'
100' — 1"= 30'
0 50' 100' — 1"= 20'

FULL SIZE PLANS HAVE BEEN PREPARED USING STANDARD ENGINEERING SCALES. REDUCED SIZED PLANS WILL NOT CONFORM TO STANDARD SCALES. IN MAKING MEASUREMENTS ON REDUCED PLANS, THE ABOVE SCALES MAY BE USED.




CONTRACT NO. XXXXX

STATE OF ILLINOIS DEPARTMENT OF TRANSPORTATION

PLANS FOR PROPOSED FEDERAL-AID HIGHWAY

FAU 0098 (N. STATE STREET)
HAMPSHIRE CREEK TO ALLEN ROAD
ROADWAY RESURFACING
SECTION 24-00022-00-RS
PROJECT NUMBER: SLD7 (215)
VILLAGE OF HAMPSHIRE
KANE COUNTY
JOB NO. C-91-275-24

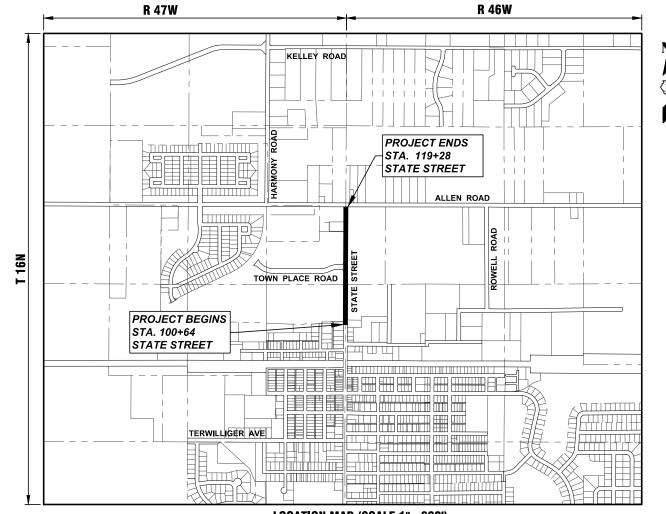

LOCATION MAP (SCALE 1"=800")

N 1/2 SECTION 21/22, T16N, R 46/47W, HAMPSHIRE TOWNSHIP
GROSS LENGTH OF PROJECT = 1,864 FEET (0.353 MILES)

NET LENGTH OF PROJECT = 1,864 FEET (0.353 MILES)



	STATE OF ILLINOIS DEPARTMENT OF TRANSPORTATION	
APPROVED		
-	VILLAGE OF HAMPSHIRE, VILLAGE MANAGER	
PASSED		
RELEASING FOR BID BASED ON LIMITED REVIEW	DISTRICT 1 ENGINEER OF LOCAL ROADS & STREETS	
	REGIONAL ENGINEER	

DATE:		ENG\HA2407-
CHRISTOPHER J. OTT		DWG FINAL
LICENSE EXPIRES: NOVEMBER 30, 2025		1\HA2407
SHEETS: 1-18	SEAL	IRE\2024\



Engineering Enterprises, Inc. CONSULTING ENGINEERS

52 Wheeler Road Sugar Grove, Illinois 60554 Phone: (630) 466-6700

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OF THE STATE OF ILLINOIS

SCHAUMBURG IL CARMEN E. RAMOS P. ENGINEER, **EDERAL AID PROGRAM**

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NAME = H:\SDSKPRC

NO SUBSTITUTIONS OR VARIANCES WILL BE PERMITTED TO ANY STANDARD NOTES OR ORDINANCES UNLESS APPROVED OTHERWISE IN WRITING PRIOR TO COMMENCING CONSTRUCTION ACTIVITY.

ALL TRAFFIC CONTROL AND OTHER ADVISORY SIGNS NEEDED FOR CONSTRUCTION ARE TO BE FURNISHED BY THE CONTRACTOR IN ACCORDANCE WITH ARTICLE 107.14 OF THE STANDARD

THE CONTRACTOR SHALL AT ALL TIMES PROVIDE PROTECTION FOR TRAFFIC AS CALLED FOR IN THE APPLICATION OF TRAFFIC CONTROL DEVICES, THE STANDARD SPECIFICATIONS, THE SPECIAL PROVISIONS AND THE PLANS

THE CONTRACTOR SHALL COOPERATE WITH THE OWNER IF ANY UTILITY IMPROVEMENTS ARE REQUIRED WITHIN THE DURATION OF THE CONTRACT.

THE CONTRACTOR SHALL BE RESPONSIBLE FOR CONTACTING THE OWNERS OF ALL UTILITIES PRIOR TO CONSTRUCTION TO DETERMINE THE LOCATION OF ALL EXISTING AND PROPOSED UTILITY EQUIPMENT. THE CONTRACTOR SHALL COOPERATE WITH ALL UTILITY OWNERS AS PROVIDED FOR IN THE STANDARD SPECIFICATIONS IF UTILITY RELOCATION, ADJUSTMENT, OR PROTECTION IS

THE LOCATION OF EXISTING DRAINAGE STRUCTURES, STORM SEWERS, WATER MAINS, SANITARY SEWERS, FIELD TILES AND ANY OTHER PUBLIC OR PRIVATE UTILITIES AS SHOWN ON THE PLANS IS APPROXIMATE AND NOT NECESSARY COMPLETE: THEIR EXACT LOCATION IS TO BE DETERMINED IN THE FIELD BY THE CONTRACTOR.

BEFORE STARTING ANY EXCAVATION, THE CONTRACTOR SHALL CALL "JULIE" (JOINT UTILITY LOCATION INFORMATION FOR EXCAVATION) AT (800) 892-0123 FOR FIELD LOCATIONS OF BURIED UTILITIES (48 HOURS NOTIFICATION IS REQUIRED).

IF EXISTING UTILITY LINES OF ANY NATURE ARE ENCOUNTERED WHICH CONFLICT IN LOCATION WITH NEW CONSTRUCTION, THE CONTRACTOR SHALL NOTIFY THE ENGINEER SO THAT THE CONFLICT MAY

UNDER NOT CIRCUMSTANCES SHALL THE CONTRACTOR OPERATE ANY VALVES OR HYDRANTS.

STAKING

THE CONTRACTOR SHALL PROTECT AND CAREFULLY PRESERVE ALL SECTION OR SUBSECTION MONUMENTS, PROPERTY CORNERS, AND REFERENCE MARKERS UNTIL THE OWNER, THE OWNER'S AGENT, OR AN AUTHORIZED SURVEYOR HAS WITNESSED OR OTHERWISE REFERENCED THEIR

ALL OFFSET LOCATIONS GIVEN ON THE DETAILED PLANS ARE FROM THE CENTERLINE AS SHOWN ON THE PLANS.

THE THICKNESS OF ASPHALT MIXTURES SHOWN IN THE PLANS ARE NOMINAL. DEVIATIONS MAY OCCUR DUE TO IRREGULARITIES IN THE SURFACES OR BASES ON WHICH THE ASPHALT MIXTURES ARE TO BE PLACED.

IT IS THE CONTRACTOR'S RESPONSIBILITY TO ASCERTAIN EXISTING FIELD CONDITIONS BEFORE BIDDING ON THIS CONTRACT.

WHERE NEW WORK MEETS EXISTING FEATURES TO REMAIN, THE CONTRACTOR SHALL FIELD CHECK ALL DIMENSIONS AND ELEVATIONS BEFORE PROCEEDING WITH CONSTRUCTION. IMMEDIATELY NOTIFY THE ENGINEER OF ANY DISCREPANCIES.

THE CONTRACTOR WILL BE REQUIRED TO COMPLY WITH ALL STATE REGULATIONS REGARDING AIR, WATER AND NOISE POLLUTION. THE CONTRACTOR IS PROHIBITED FROM BURNING ANY MATERIAL WITHIN OR ADJACENT TO THE IMPROVEMENT.

THE ENGINEER IS NOT RESPONSIBLE FOR THE CONSTRUCTION MEANS, METHODS, TECHNIQUES, SEQUENCES OR PROCEDURES, TIME OF PERFORMANCE, PROGRAMS OR FOR ANY SAFETY PRECAUTIONS USED BY THE CONTRACTOR. THE CONTRACTOR IS SOLELY RESPONSIBLE FOR EXECUTION OF THEIR WORK IN ACCORDANCE WITH THE CONTRACT DOCUMENTS AND SPECIFICATIONS.

FOR STABILIZATION, ALL TYPE III BARRICADES WILL REQUIRE A MINIMUM OF FOUR SAND BAGS PER

THE CONTRACTOR SHALL MAINTAIN EXISTING SIDE STREET AND DRIVEWAY ACCESS TO EACH ABUTTING PROPERTY AT ALL TIMES DURING CONSTRUCTION OF THE PROJECT UNLESS OTHERWISE NOTED ON THE PLANS OR DIRECTED BY THE ENGINEER.

THE CONTRACTOR SHALL DISPOSE OF AND REMOVE FROM THE SITE EACH DAY ALL CURB, GUTTER,

THE ROADWAY ELEVATION FROM STATION 100+64 TO STATION 119+28 SHALL NOT CHANGE.

THE STORAGE OF EQUIPMENT AND/OR MATERIALS WITHIN THE RIGHT-OF-WAY OF ANY STREET SHALL REQUIRE PRIOR APPROVAL OF THE ENGINEER.

COMBINATION CONCRETE CURB AND GUTTER REMOVAL AND REPLACEMENT AS SHOWN ON THE PLANS IS FOR INFORMATIONAL PURPOSES ONLY. ACTUAL LOCATIONS AND QUANTITIES ARE TO BE DETERMINED AND MARKED BY THE ENGINEER PRIOR TO CONSTRUCTION.

ALL EXISTING SIGNS (INCLUDING THOSE LOCATED ON UTILITY/LIGHT POLES) THAT DO NOT CONFLICT WITH THE IMPROVEMENTS SHALL REMAIN IN PLACE UNLESS DIRECTED BY THE ENGINEER.

CONTRACTOR SHALL TAKE PRECAUTION BY PRESERVING EXISTING TREES WITHIN THE RIGHT OF WAY. IF ANY DAMAGE OCCURS, TREES SHALL BE REPLACED IN KIND PER ARTICLE 201.07 REPAIR OR REPLACEMENT OF EXISTING PLANT MATERIAL REQUIREMENT STATED HEREIN.

IDOT HIGHWAY STANDARDS

000001-08	STANDARD SYMBOLS, ABBREVIATIONS, AND PATTERNS
280001-07	TEMPORARY EROSION CONTROL SYSTEMS
442201-03	CLASS C AND D PATCHES
604001-05	FRAME AND LIDS TYPE 1
604006-05	FRAME AND GRATE TYPE 3
606001-08	CONCRETE CURB TYPE B AND COMBINATION CONCRETE CURB AND GUTTER
701006-05	OFF-RD OPERATIONS, 2L, 2W, 15'(4.5M) TO 24" (600MM) FROM PAVEMENT EDGE
701011-04	OFF-RD MOVING OPERATIONS, 2L, 2W, DAY ONLY
701301-04	LANE CLOSURE, 2L, 2W, SHORT TIME OPERATIONS
701311-03	LANE CLOSURE, 2L, 2W, MOVING OPERATIONS - DAY ONLY
701501-06	URBAN LANE CLOSURE 2L, 2W, UNDIVIDED
701502-09	URBAN LANE CLOSURE 2L, 2W, WITH BIDIRECTIONAL LEFT TURN LANE
701901-10	TRAFFIC CONTROL DEVICES
780001-05	TYPICAL PAVEMENT MARKINGS
781001-04	TYPICAL APPLICATIONS RAISED REFLECTIVE PAVEMENT MARKERS

INDEX OF SHEETS

SHEET NO. SHEET DESCRIPTION INDEX OF SHEETS, DETAILS, HIGHWAY STANDARDS, AND GENERAL NOTES 2. 3.-5. SUMMARY OF QUANTITIES TYPICAL SECTIONS 7.-9 RESURFACING PLAN

IDOT DISTRICT 1 DETAILS

10.-18.


LEGEND

HOT-MIX ASPHALT SURFACE REMOVAL, 3.75" AND RESURFACING

HOT-MIX ASPHALT SURFACE REMOVAL, BUTT-JOINT

COMB CONC C&G REMOVAL AND REPLACEMENT

IDOT DISTRICT ONE STD. SHEET. NO. 10. (BD-08) FRAMES AND LIDS ADJUSTMENT WITH MILLING (BD-22) PAVEMENT PATCHING FOR HMA SURFACED 11. (BD-24) CURB OR CURB AND GUTTER REMOVAL AND REPLACEMENT 12. 13. (BD-32) BUTT JOINT AND HMA TAPER DETAILS (TC-10) TRAFFIC CONTROL AND PROTECTION FOR 14. SIDE ROADS, INTERSECTIONS, AND (TC-11) RAISED REFLECTIVE PAVEMENT MARKERS (SNOW-PLOW RESISTANT) 15. (TC-13) TYPICAL PAVEMENT MARKINGS 17. (TC-16) SHORT TERM PAVEMENT MARKING LETTERS AND SYMBOLS (TC-22) ARTERIAL ROAD INFORMATION SIGN

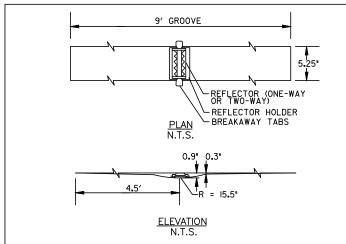

INSTALLATION NOTES:

I. SAW CUT TO DIMENSIONS SHOWN.

TO STA.

- SAW CUT AREAS TO BE DRY AND FREE OF MATERIAL THAT ADVERSELY AFFECTS THE ADHESIVE BOND.
- INSTALL THE REFLECTOR WITH AN APPROVED TWO-COMPONENT EPOXY ADHESIVE. EPOXY SHOULD NOT OBSCURE OR BLOCK THE LENS.
- 4. REFLECTOR SHALL BE 3M SERIES 190.
- 5. THE REFLECTOR HOLDER SHALL BE MARKERONE SERIES RIOO REFLECTOR HOLDER.
- FOR I-WAY MARKERS HEADING UPHILL, UPHILL GRIND TAPER MAY BE OMITTED.
- MARKER PLACEMENT AND COLOR SHALL CONFORM TO IDOT DISTRICT I HIGHWAY STANDARD TC-II.

RECESSED REFLECTIVE PAVEMENT MARKERS



Engineering Enterprises, Inc. CONSULTING ENGINEERS

DESIGNED -REVISED DRAWN REVISED CHECKED -REVISED REVISED

STATE OF ILLINOIS DEPARTMENT OF TRANSPORTATION **GENERAL NOTES, HIGHWAY STANDARDS, LEGEND AND INDEX OF SHEETS**

SHEET 1 OF 1 SHEETS STA.

SCALE: N.T.S.

SECTION SHEETS COUNTY 24-00022-00-RS KANE I8 2 0098 CONTRACT NO. XXXXXX TILLINOIS FED. AID PROJECT

CODE NUMBER	ITEM DESCRIPTION	UNIT	ROADWAY 75% FEDERAL 25% LOCAL 0005
21101615	TOPSOIL FURNISH AND PLACE, 4"	SQYD	70
25200110	SODDING, SALT TOLERANT	SQYD	70
25200200	SUPPLEMENTAL WATERING	UNIT	5
28000250	TEMPORARY EROSION CONTROL SEEDING	POUND	20
28000510	INLET FILTERS	EACH	20
40600290	BITUMINOUS MATERIALS (TACK COAT)	POUND	5,065
40600370	LONGITUDINAL JOINT SEALANT	FOOT	1,864
40600400	MIXTURE FOR CRACKS, JOINTS, AND FLANGEWAYS	TON	5
40600982	HOT-MIX ASPHALT SURFACE REMOVAL - BUTT JOINT	SQYD	75
40603080	HOT-MIX ASPHALT BINDER COURSE, IL-19.0, N50	TON	980
40604060	HOT-MIX ASPHALT SURFACE COURSE, IL-9.5, MIX "D", N50	TON	655
44000164	HOT-MIX ASPHALT SURFACE REMOVAL, 3 3/4"	SQ YD	7,500
44000500	COMBINATION CURB AND GUTTER REMOVAL	FOOT	300
60255500	MANHOLES TO BE ADJUSTED	EACH	1

Δ INDICATES SPECIALTY ITEM

YEARS EX	Engineering Enterprises, Inc. CONSULTING ENGINEERS 52 Wheeler Road Sugar Grove, Illinois 60554
	630,466,6700 / www.eeiweb.com

DESIGNED -	REVISED -
DRAWN -	REVISED -
CHECKED -	REVISED -
DATE -	REVISED -

	DDE ITEM DESCRIPTION		UNIT	ROADWAY 75% FEDERAL 25% LOCAL 0005	
6026	60100	INLETS TO BE ADJUSTED	EACH	20	
6040	04300	FRAMES AND GRATES, TYPE 3	EACH	2	
6040	06100	FRAMES AND LIDS, TYPE 1, CLOSED LID	EACH	1	
6060	04400	COMBINATION CURB AND GUTTER, TYPE B-6.18	FOOT	300	
6710	00100	MOBILIZATION	LSUM	1	
7010	02620	TRAFFIC CONTROL AND PROTECTION, STANDARD 701501	LSUM	4.	
7030	00100	SHORT TERM PAVEMENT MARKING	FOOT	900	
7030	00150	SHORT TERM PAVEMENT MARKING REMOVAL	SQ FT	300	
7030	00211	TEMPORARY PAVEMENT MARKING - LINE 4" - PAINT	FOOT	3,730	
7800	00100	THERMOPLASTIC PAVEMENT MARKING - LETTERS AND SYMBOLS	SQFT	109.2	
7800	00200	THERMOPLASTIC PAVEMENT MARKING - LINE 4"	FOOT	5,656	
7800	00400	THERMOPLASTIC PAVEMENT MARKING - LINE 6"	FOOT	426	
7800	00600	THERMOPLASTIC PAVEMENT MARKING - LINE 12"	FOOT	337	
7800	00650	THERMOPLASTIC PAVEMENT MARKING - LINE 24"	FOOT	.24	

Δ INDICATES SPECIALTY ITEM



DESIGNED	-	REVISED -
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CHECKED	-	REVISED -
DATE	-	REVISED -

	CHM	MAD	V OF OIL	MITITIES	,	F.A.U. RTE.	SECTION	COUNTY	TOTAL SHEETS	SHEET NO.
	20 IAI	WAN	Y OF QUA	4MIIIIE2	•	0098	24-00022-00-RS	KANE	18	4
								CONTRACT I	۷0. XXX	XXXX
SCALE: N.T.S.	SHEET 2	OF	3 SHEETS	STA.	TO STA.		ILLINOIS FED. AI	D PROJECT		+00

UNIT	ROADWAY 75% FEDERAL 25% LOCAL 0005	
EACH	100	
SQYD	528	
EACH	100	
SQ FT	77.1	
	EACH SQ YD EACH	


Δ INDICATES SPECIALTY ITEM

44	Engineering Enterprises, Inc. CONSULTING ENGINEERS
YEARS 2	52 Wheeler Road Sugar Grove, Illinois 60554 630 466 6700 / www.eeiweb.com

DESIGNED -	REVISED -
DRAWN -	REVISED -
CHECKED -	REVISED -
DATE -	REVISED -

STATE OF ILLINOIS DEPARTMENT OF TRANSPORTATION

							F.A.U. RTE.	SECTION	COUNTY TO		OTA EE1	
SUMMARY OF QUANTITIES						0098	24-00022-00-	24-00022-00-RS KANE			18	
									CONTRACT	NO.	$\overline{}$	
SCALE: N.T.S.	SHEET 3	OF	3	SHEETS	STA.	TO STA.		ILLINOIS	FED. A	D PROJECT		

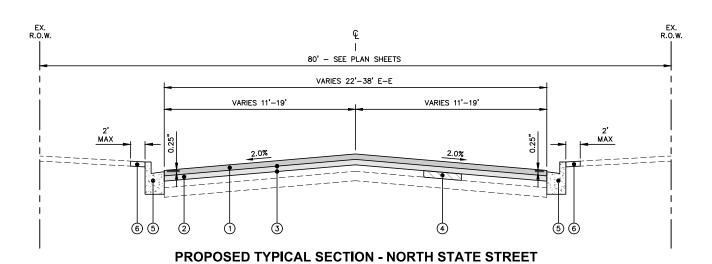

STA 100+64 TO STA 119+28

HOT-MIX ASPHALT MIXTURE REQUIREMENTS

EXISTING LEGEND A EXISTING HOT-MIX ASPHALT PAVEMENT (15") B EXISTING AGGREGATE BASE COURSE (4" - 7") © EXISTING COMBINATION CONCRETE CURB & GUTTER. B6.18 D EXISTING PARKWAY E HOT-MIX ASPHALT SURFACE REMOVAL, 3.75" F PARTIAL DEPTH PATCHING (SPECIAL) - REMOVAL (LOCATIONS TO BE DETERMINED BY ENGINEER) G EXISTING SOD-REMOVAL

OPERATION	MIXTURE TYPE	AIR VOIDS • NDES	QMP
PAVEMENT RESURFACING	HOT-MIX ASPHALT SURFACE COURSE, IL-9.5, MIX "D", N50, 1.5" HOT-MIX ASPHALT BINDER COURSE, IL-19.0, N50, 2.25"	4% @ 50 GYR. 4% @ 50 GYR.	QC/QA QC/QA
PARTIAL DEPTH PATCHING	HOT-MIX ASPHALT BINDER COURSE, IL-19.0, N70, 6"	4% @ 70 GYR.	QC/QA
	QMP DESIGNATION: QUALITY CONTROL/QUALITY ASSURANCE (QC/QA) PER LR 1030-2.		

THE UNIT WEIGHT TO CALCULATE ALL HMA SURFACE MIXTURE QUANTITIES IS 112 LBS/SQ YD/IN

THE "AC TYPE" FOR POLYMERIZED HMA MIXES SHALL BE "SBS/SBR PG 76-22" AND FOR NON-POLYMERIZED HMA THE "AC TYPE" SHALL BE "PG 64-22". UNLESS MODIFIED BY RECLAIMED MATERIALS SPECIFICATIONS.

PROPOSED	LEGEND
FROFUSED	LEGEND

- 1 HOT-MIX ASPHALT SURFACE COURSE, IL-9.5, MIX "D", N50, 1.5"
- 2 HOT-MIX ASPHALT BINDER COURSE, IL-19.0, N50, 2.25"
- 3 BITUMINOUS MATERIALS (TACK COAT)
- (4) PARTIAL DEPTH PATCHING (SPECIAL), 6" (LOCATIONS TO BE DETERMINED BY ENGINEER)
- (SPOT REMOVAL AND REPLACEMENT AS DIRECTED BY THE ENGINEER)
- 6 TOPSOIL AND SODDING, SALT TOLERANT

NOTES:
THE PATCHING QUANTITIES HAVE BEEN ESTIMATED BASED ON FIELD
OBSERVATIONS DURING DESIGN. ACTUAL QUANTITIES TO BE DETERMINED
DURING CONSTRUCTION.

NO PROPOSED WORK WILL TAKE PLACE OUTSIDE OF THE R.O.W.

TO STA. N/A

50	44.	Engineering Enterprises, consulting engineers
YEARS	W.	52 Wheeler Road Sugar Grove, Illinois 60554 630.466.6700 / www.eeiweb.cc

Inc.		
om		
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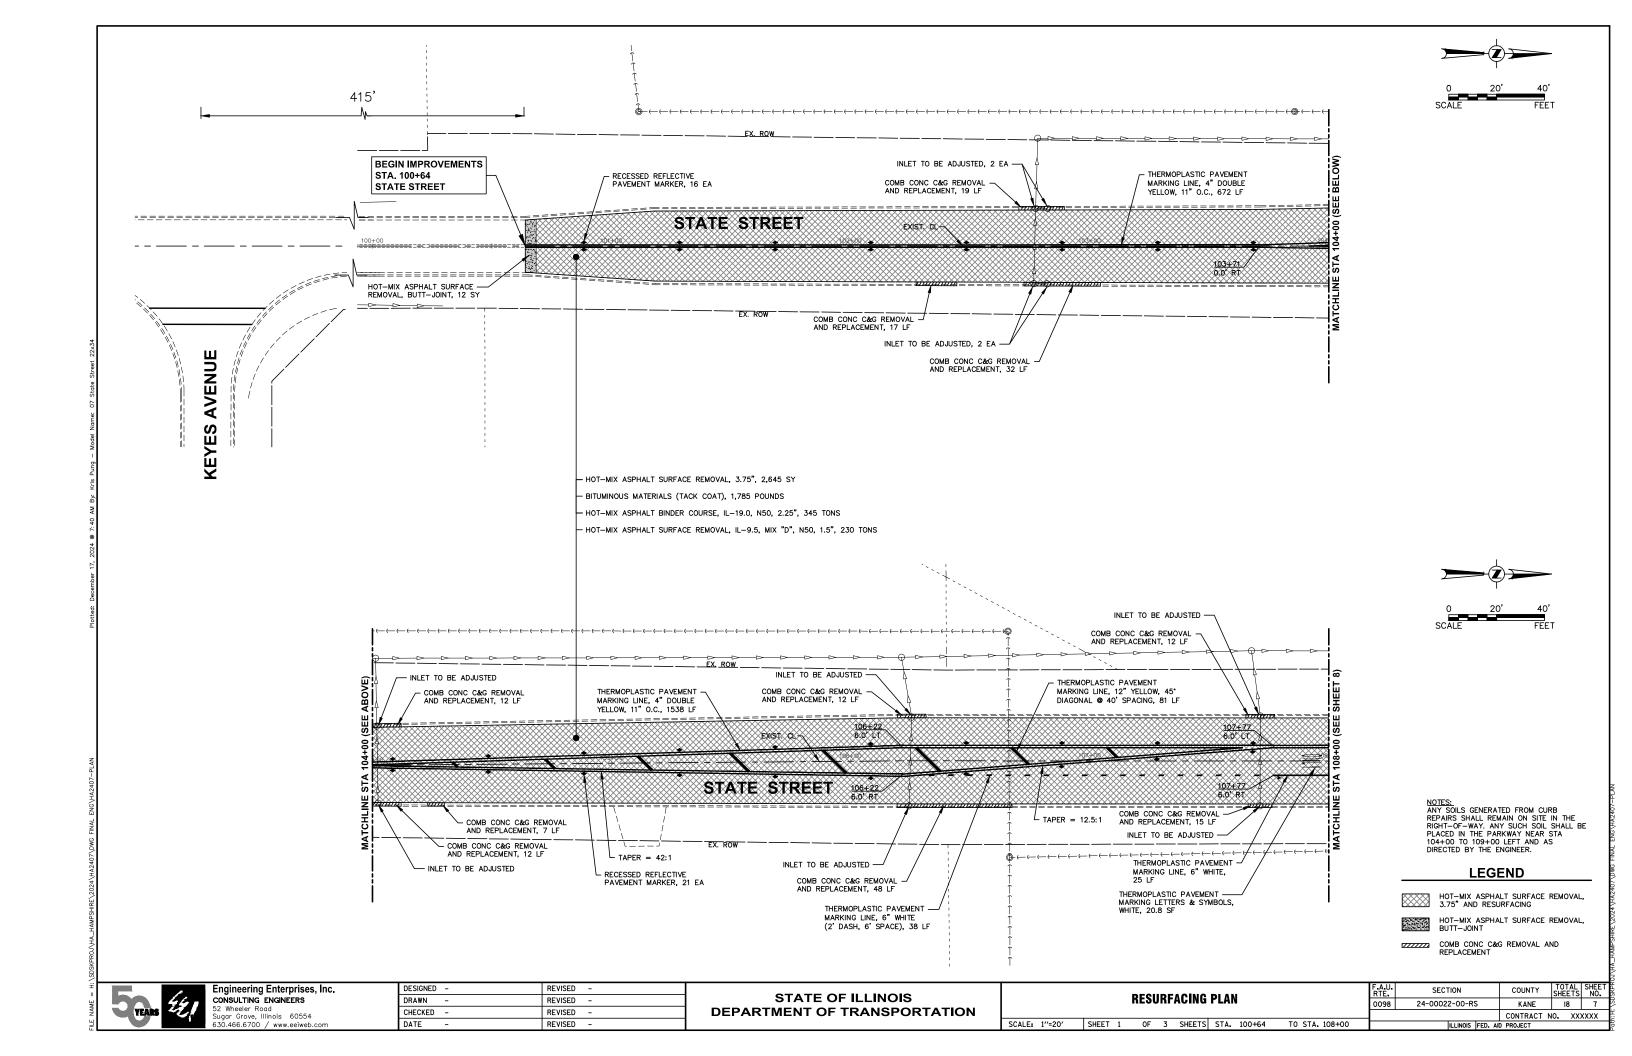
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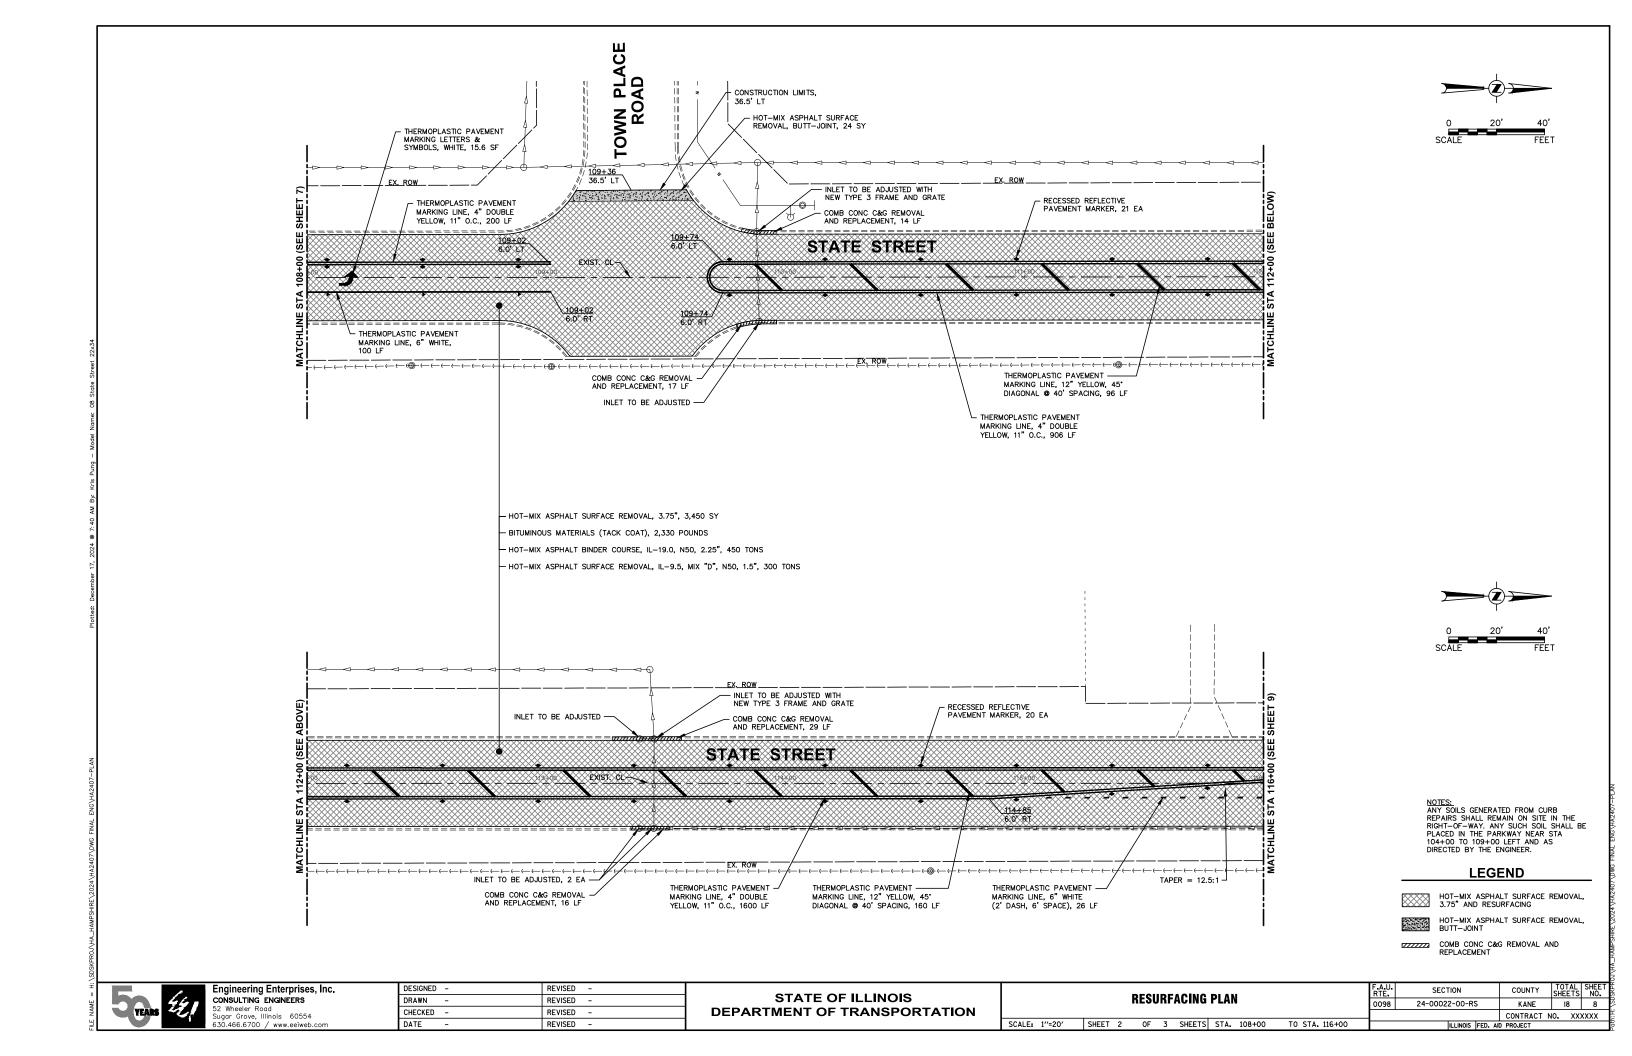
STATE OF ILLINOIS DEPARTMENT OF TRANSPORTATION


			TYPIC	CAI	. SECTI	ONS
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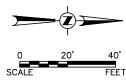
A.U. TE.	SECTION	COUNTY	TOTAL SHEETS	SHEE.					
98	24-00022-00-RS	KANE	18	6					
		CONTRACT N	10. XX	XXXX					
	III I INOIS FED. AID PROJECT								

NG ENGINEERS Road e, Illinois 60554 00 / www.eeiweb.c







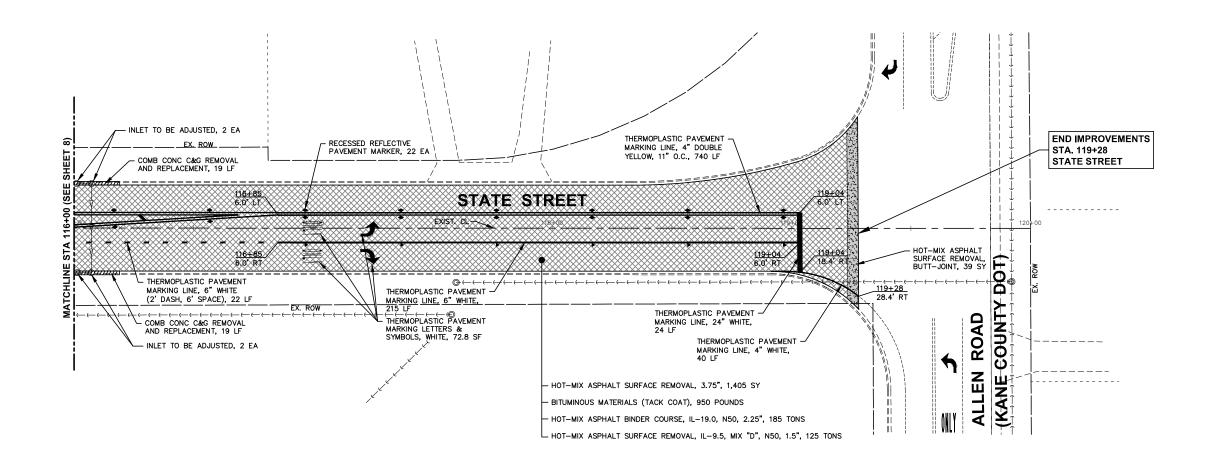

NOTES:
ANY SOILS GENERATED FROM CURB
REPAIRS SHALL REMAIN ON SITE IN THE
RIGHT-OF-WAY. ANY SUCH SOIL SHALL BE
PLACED IN THE PARKWAY NEAR STA
104+00 TO 109+00 LEFT AND AS
DIRECTED BY THE ENGINEER.

LEGEND

HOT-MIX ASPHALT SURFACE REMOVAL, 3.75" AND RESURFACING



HOT-MIX ASPHALT SURFACE REMOVAL, BUTT-JOINT

COMB CONC C&G REMOVAL AND REPLACEMENT



Engineering Enterprises, Inc. CONSULTING ENGINEERS 52 Wheeler Road Sugar Grove, Illinois 60554 630.466.6700 / www.eeiweb.com


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CHECKED -	REVISED -
DATE -	REVISED -

STATE OF ILLINOIS DEPARTMENT OF TRANSPORTATION

				RESU	RF	ACING	PLAN	i			
SCALE:	1"=20"	SHEET	3	OF	3	SHEETS	STA.	116+00	TO	STA.	119+28

SECTION COUNTY TOTAL SHEET NO. 24-00022-00-RS KANE 18 9 0098 CONTRACT NO. XXXXXX

ILLINOIS FED. AID PROJECT

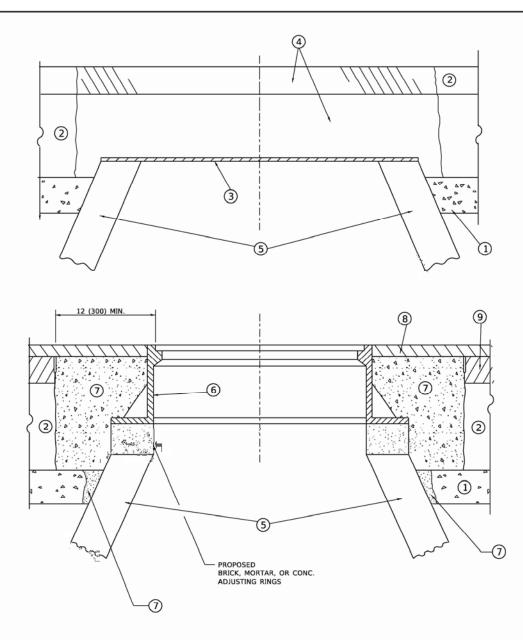

DETAILS FOR FRAMES AND LIDS ADJUSTMENT

NOTES

- 1. EXISTING BROKEN FRAMES AND LIDS SHALL BE REMOVED AND DISPOSED OF BY THE CONTRACTOR AND SHALL BE REPLACED AS DIRECTED BY THE ENGINEER. REPLACEMENT FRAMES AND LIDS WILL BE PAID FOR IN ACCORDANCE WITH ARTICLE 109.04 OF THE STANDARD SPECIFICATIONS UNLESS A SEPARATE PAY ITEM HAS BEEN PROVIDED.
- IF THE EXISTING LIDS ARE OPEN, THE FRAME WILL BE ADJUSTED TO THE ELEVATION OF THE MILLED PAVEMENT SURFACE PRIOR TO THE MILLING OPERATION. THE FRAME WILL NOT BE REMOVED AND COVERED BY THE METAL PLATE.
- CITY OF CHICAGO CASTINGS ARE THE PROPERTY OF THE CITY AND THE CONTRACTOR SHALL NOTIFY THE CITY FOR REMOVAL AND DISPOSITION OF THE CASTINGS.
- THE METAL PLATE USED TO COVER THE STRUCTURE SHALL REMAIN THE PROPERTY OF THE CONTRACTOR.
- THE CONTRACTOR SHALL REMOVE ALL TRAFFIC CONTROL DEVICES BY THE END OF EACH WORK SHIFT.

WITH MILLING

CONSTRUCTION PROCEDURES

STAGE 1 (BEFORE PAVEMENT MILLING)

- A) REMOVE A MINIMUM OF 12 (300) OF THE PAVEMENT FROM AROUND THE STRUCTURE.
- B) REMOVE THE EXISTING FRAME AND LID FROM THE STRUCTURE.
- C) COVER THE STRUCTURE OPENING WITH A 36 (900) DIAMETER METAL PLATE.
- D) BACKFILL WITH CRUSHED STONE AND HMA SURFACE MIX APPROVED BY THE ENGINEER. (MIN. 3 (80) HMA TO REMAIN AFTER MILLING).

STAGE 2 (AFTER PAVEMENT MILLING)

- A) REMOVE THE HMA SURFACE MIX AND CRUSHED STONE.
- B) INSTALL THE FRAME AND LID; ADJUST THE FRAME TO ITS FINAL SURFACE ELEVATION.
- C) THE SURROUNDING SPACE SHALL BE FILLED WITH CLASS PP-2* CONCRETE TO THE ELEVATION OF THE SURFACE OF THE EXISTING BASE COURSE OR THE BINDER COURSE.
- *UNLESS OTHERWISE SPECIFIED IN THE PLANS.

THE PROCEDURE EXPLAINED ABOVE SHALL CONFORM TO THE APPLICABLE PORTIONS OF SECTIONS 353, 406, 602, AND 603 OF THE STANDARD SPECIFICATIONS EXCEPT THAT "THE CONTRACTOR SHALL ADJUST THE STRUCTURES TO THE FINISHED PAVEMENT ELEVATION NO MORE THAN 5 CALENDAR DAYS PRIOR TO PLACEMENT OF THE FINAL LIFT OF SURFACE UNLESS APPROVED BY THE ENGINEER."

LEGEND

SUB-BASE GRANULAR MATERIAL	6 FRAME AND LID (SEE NOTES)
-------------------------------	-----------------------------

② EXISTING PAVEMENT

(5) EXISTING STRUCTURE

(7) CLASS PP-2* CONCRETE

3 36 (900) DIAMETER METAL PLATE

8 PROPOSED HMA SURFACE COURSE

4 PROPOSED CRUSHED STONE AND HMA SURFACE MIX

PROPOSED HMA BINDER COURSE

LOCATION OF STRUCTURES

THE CONTRACTOR WILL BE REQUIRED TO KEEP A RECORD OF THE LOCATIONS OF THE BURIED STRUCTURES ACCORDING TO THE STATION AND DISTANCE LEFT OR RIGHT OF THE CENTERLINE OF PAVEMENT. UPON COMPLETION OF THE WORK, THE CONTRACTOR WILL DELIVER THE RECORD TO THE ENGINEER.

BASIS OF PAYMENT

- 1. REMOVING FRAMES AND LIDS ON DRAINAGE AND UTILITY STRUCTURES IN THE PAVEMENT PRIOR TO MILLING, AND ADJUSTING TO FINAL GRADE PRIOR TO PLACING THE SURFACE COURSE, WILL BE PAID FOR AT THE CONTRACT UNIT PRICE EACH FOR "FRAMES AND LIDS TO BE ADJUSTED (SPECIAL)."
- THIS WORK WILL NOT BE PAID FOR WHEN DRAINAGE AND UTILITY STRUCTURES ARE SPECIFIED FOR PAYMENT AS STRUCTURE RECONSTRUCTION.
- NEW FRAMES AND LIDS, WHEN SPECIFIED, WILL BE PAID FOR SEPARATELY.
- 4. WHEN STRUCTURES ARE TO BE ADJUSTED OR RECONSTRUCTED, THE LOWERING AND RAISING OF THE FRAMES AND LIDS WILL NOT BE PAID FOR SEPARATELY BUT WILL BE INCLUDED IN THE COST OF THE CORRESPONDING PAY ITEM.

ALL DIMENSIONS ARE IN INCHES (MILLIMETERS) UNLESS OTHERWISE SHOWN


USER NAME = Lawrence.DeManche	DESIGNED - R. SHAH	REVISED - R. BORO 03-09-11		DETAILS FOR F.A.U. RTE. SECTION COUNTY TOTAL SHEETS NO.
	DRAWN -	REVISED - R. BORO 12-06-11	STATE OF ILLINOIS	0000 04 00000 00 PC 1/1/15 40 40
PLOT SCALE = 100.0000 ' / in.	CHECKED -	REVISED - K. SMITH 11-18-22	DEPARTMENT OF TRANSPORTATION	FRAMES AND LIDS ADJUSTMENT WITH MILLING 0098 24-00022-00-RS KANE 18 10
PLOT DATE = 9/15/2023	DATE - 10-25-94	REVISED - K SMITH 09-15-23	1	SCALE: NONE SHEET 1 OF 1 SHEETS STA. TO STA. THUNDON SED AND BROJECT

METHOD OF MEASUREMENT

REFER TO SECTION 442 OF THE STÄNDARD SPECIFICATIONS FOR ROAD AND BRIDGE CONSTRUCTION AND THE RECURRING SPECIAL PROVISION "PATCHING WITH HOT-MIX ASPHALT OVERLAY REMOVAL."

BASIS OF PAYMENT

- 1. REFER TO SECTION 442 OF THE STANDARD SPECIFICATIONS FOR ROAD AND BRIDGE CONSTRUCTION AND THE RECURRING SPECIAL PROVISION "PATCHING WITH HOT-MIX ASPHALT OVERLAY REMOVAL."
- SAW CUT/SCORING OF EXISTING HMA OVERLAY IS INCLUDED IN THE COST OF PAVEMENT PATCHING.
- SAW CUT/SCORING OF EXISTING PAVEMENT IS INCLUDED IN THE COST OF PAVEMENT PATCHING.

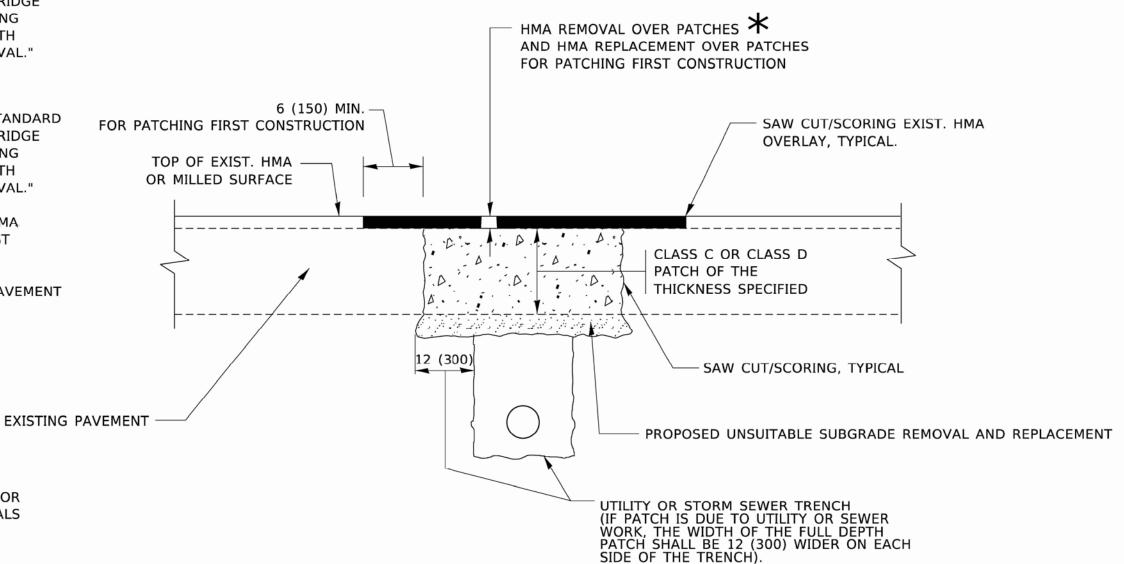

THICKNESS AND MATERIALS

* SEE TYPICAL SECTIONS FOR

- 1. REMOVE THE EXISTING HMA MATERIAL OVER THE AREA TO BE PATCHED.
- 2. REMOVE AND REPLACE WITH CLASS C OR D PATCH.

SEQUENCE OF CONSTRUCTION (PATCHING FIRST)


3. REPLACE HMA MATERIAL OVER THE AREA TO BE PATCHED.

SEQUENCE OF CONSTRUCTION (MILLING FIRST)

- 1. MILL HMA FIRST IF THERE IS AT LEAST 4½ INCHES OR MORE OF HMA MATERIAL ON TOP OF THE EXISTING PAVEMENT OR IF THE PAVEMENT IS FULL DEPTH HMA. A MINIMUM OF 2 INCHES OF HMA MATERIAL SHALL BE IN PLACE AFTER MILLING.
- 2. REMOVE AND REPLACE WITH FULL DEPTH CLASS D PATCHES TO TOP OF MILLED SURFACE.

ALL DIMENSIONS ARE IN INCHES (MILLIMETERS) UNLESS OTHERWISE SHOWN.

USER NAME = Lawrence.DeManche	DESIGNED - R. SHAH	REVISED - R. BORO 01-01-07		PAVEMENT PATCHING FOR			F.A.U.	SECTION	COUNTY	TOTAL	SHEET
	DRAWN -	REVISED - R. BORO 09-04-07	STATE OF ILLINOIS				0098	24-00022-00-RS	KANE	18	11
PLOT SCALE = 100.0000 ' / in.	CHECKED -	REVISED - K. ENG 10-27-08	DEPARTMENT OF TRANSPORTATION		HMA SURFACED PAVEMENT		· · · ·	3D400-04 (BD-22)	CONTRACT	NO.	
PLOT DATE = 11/18/2022	DATE - 10-25-94	REVISED - K. SMITH 11-18-22		SCALE: NONE	SHEET 1 OF 1 SHEETS STA.	TO STA.		ILLINOIS FED. A	ID PROJECT		

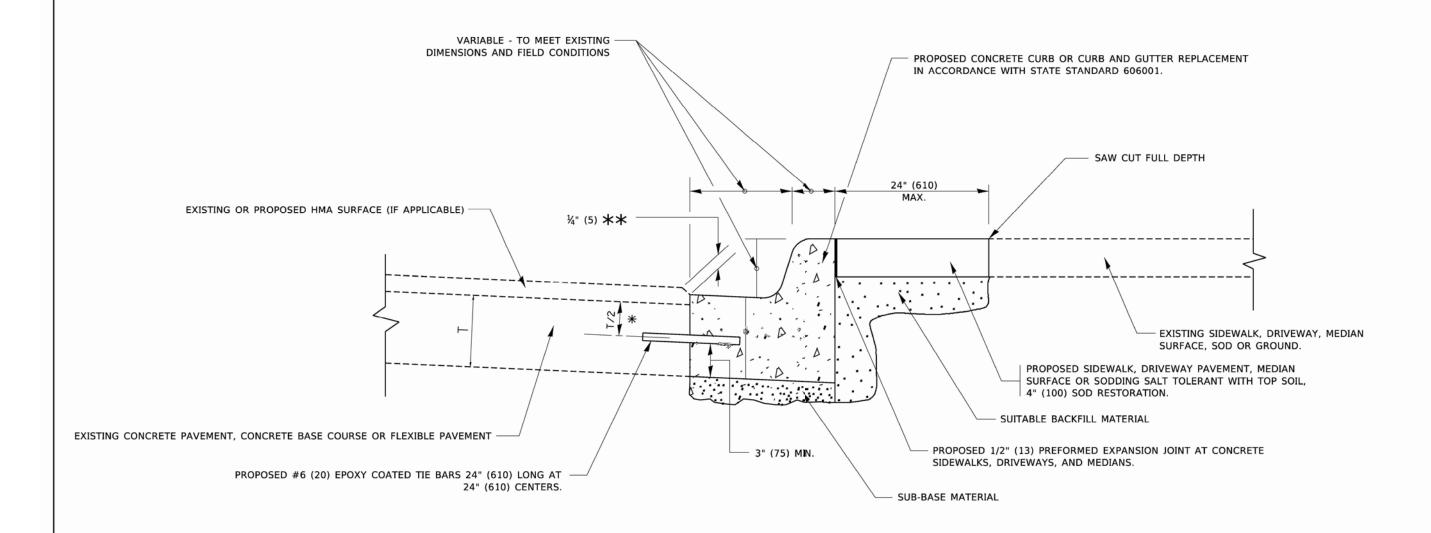


- ★ 3" (75) MINIMUM FROM TOP AND BOTTOM OF THE CONCRETE PAVEMENT OR BASE COURSE.
- ** IF THE FINAL SURFACE OF THE PAVEMENT IS CONCRETE, THE GUTTER IS TO BE FLUSH WITH THE PAVEMENT.

CURB OR CURB AND GUTTER REMOVAL AND REPLACEMENT


ALL DIMENSIONS ARE IN INCHES (MILLIMETERS) UNLESS OTHERWISE SHOWN.

USER NAME = footemj	DESIGNED - A. HOUSEH	REVISED - A. ABBAS 03-21-97		CURB OR CURB AND GUTTER	F.A.U. RTE.	SECTION	COUNTY	TOTAL	SHEET NO.
	DRAWN -	REVISED - M. GOMEZ 01-22-01	STATE OF ILLINOIS DEPARTMENT OF TRANSPORTATION	REMOVAL AND REPLACEMENT	0098	24-00022-00-RS	KANE	18	12
PLOT SCALE = 50.0000 ' / in.	CHECKED -	REVISED - R. BORO 12-15-09		REWUVAL AND REPLACEMENT		BD600-06 (BD-24)	CONTRAC	T NO.	-
PLOT DATE = 7/11/2019	DATE - 03-11-94	REVISED - K. SMITH 07-11-19		SCALE: NONE SHEET 1 OF 1 SHEETS STA. TO STA.			ID PROJECT		

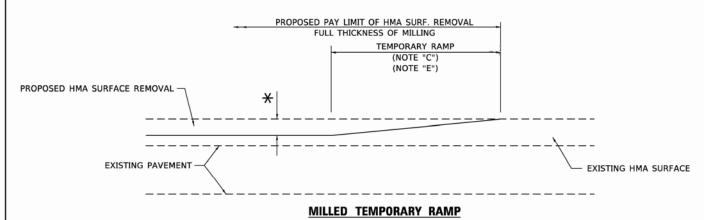

(FOR BUTT JOINT AND HMA TAPER SEE DETAIL BELOW)

OPTION 1

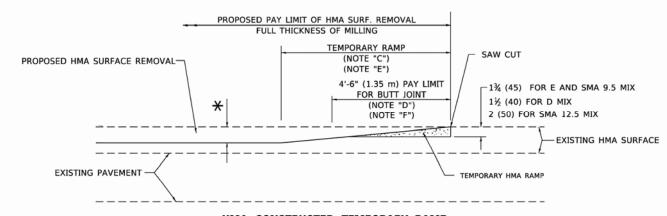


HMA CONSTRUCTED TEMPORARY RAMP


(FOR BUTT JOINT AND HMA TAPER SEE DETAIL BELOW)


OPTION 2

TYPICAL TEMPORARY RAMP

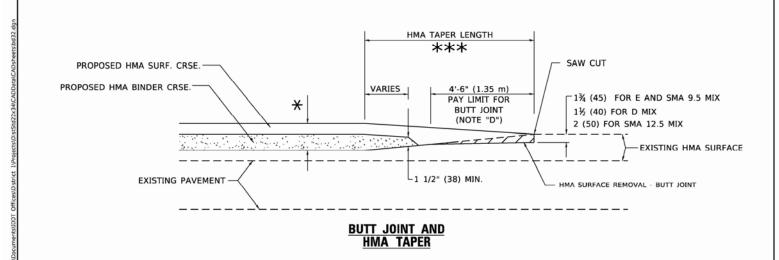

TYPICAL BUTT JOINT AND HMA TAPER FOR MILLING AND RESURFACING

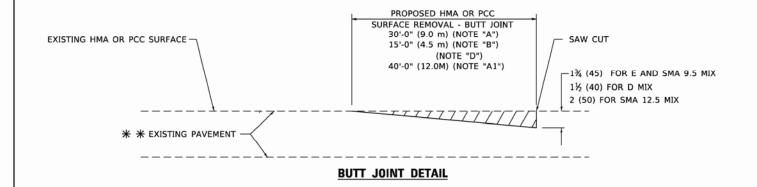

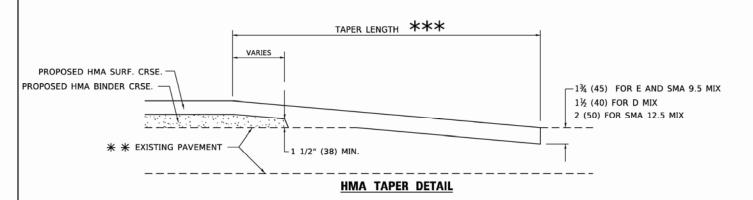

TYPICAL BUTT JOINT AND HMA TAPER FOR RESURFACING ONLY

** PC CONCRETE, HMA OR HMA RESURFACED PAVEMENT.

GENERAL NOTES

- A. MAINLINE ARTERIAL ROADWAYS AND MAJOR SIDE ROADS.
- A1. INTERSTATES
- B. MINOR SIDE ROADS.
- C. THE TEMP. RAMP SHALL BE CONSTRUCTED IMMEDIATELY UPON REMOVAL OF THE EXISTING HMA SURFACE.
- D. THE BUTT JOINT SHALL BE CONSTRUCTED IMMEDIATELY PRIOR TO PLACING THE PROPOSED HMA COURSES.
- E. TAPER THE TEMP. RAMP AT A RATE OF 3' 4" (1.02m) PER 1 INCH (25 mm) OF MILLING THICKNESS.

SHEET 1

- * SEE TYPICAL SECTIONS FOR MILLING THICKNESS.
- SEE ARTICLE 406.08 AND 406.14 OF THE STANDARD SPECIFICATIONS FOR "HMA AND/OR PCC SURFACE REMOVAL, BUTT JOINT".
- *** 20'-0" (6.1 m) PER 1 (25) RESURFACING (NOTE "A") 10'-0" (3.0 m) PER 1 (25) RESURFACING (NOTE "B")

BASIS OF PAYMENT

- THE BUTT JOINT WILL BE PAID FOR AT THE CONTRACT UNIT PRICE PER SQUARE YARD (SQUARE METER) FOR "HOT-MIX ASPHALT SURFACE REMOVAL - BUTT JOINT" OR FOR "PORTLAND CEMENT CONCRETE SURFACE REMOVAL- BUTT JOINT"
- THE TEMPORARY RAMP AND SAW CUT SHALL BE INCLUDED IN THE UNIT COST FOR HMA OR PCC SURFACE REMOVAL-BUTT JOINT.


ALL DIMENSIONS ARE IN INCHES (MILLIMETERS) UNLESS OTHERWISE SHOWN.

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PLOT SCALE = 100.0000 ' / in.	CHECKED -	REVISED - R. BORO 01-01-07	DEPARTMENT OF
PLOT DATE = 11/18/2022	DATE - 06-13-90	REVISED - K. SMITH 11-18-22	

DESIGNED - M. DE YONG REVISED - A. ABBAS 03-21-97

STATI	E OI	FILLINOIS
DEPARTMENT	0F	TRANSPORTATION

								_
BUTT	JOINT	AND		F.A.U. RTE.	SECTION	COUNTY	TOTAL SHEETS	7.5
HMA TAPER DETAILS				0098	24-00022-00-RS	KANE	18	Γ
					BD400-05 BD-32	CONTRACT	NO.	_
OF 1	SHEETS	STA.	TO STA.		TILINOIS FED A	ID PROJECT		_

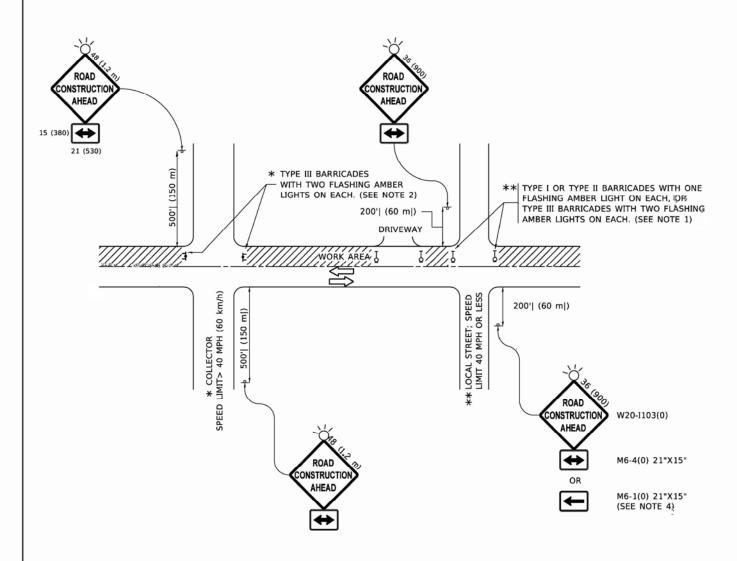

NOTES:

- SIDE ROAD WITH A SPEED LIMIT OF 40 MPH (60 km/h) OR LESS AS SHOWN ON THE DRAWING AND AS DIRECTED BY THE ENGINEER:
- a) ONE "ROAD CONSTRUCTION AHEAD" SIGN 36 x 36 (900x900) WITH A FLASHER MOUNTED ON IT APPROXIMATELY 200' (60 m) IN ADVANCE OF THE MAIN ROUTE.
- b) THE CLOSED PORTION OF THE MAIN ROUTE SHALL BE PROTECTED BY BLOCKING WITH TYPE I, TYPE II OR TYPE III BARRICADES, 1/3 OF THE CROSS SECTION OF THE CLOSED PORTION.
- SIDE ROAD WITH A SPEED LIMIT GREATER THAN 40 MPH (60 km/h) AS SHOWN ON THE DRAWING AND AS DIRECTED BY THE ENGINEER:
- a) ONE "ROAD CONSTRUCTION AHEAD" SIGN 48 x 48 (1.2 m x 1.2 m) WITH A FLASHER MOUNTED ON IT APPROXIMATELY 500' (150 m) IN ADVANCE OF THE MAIN ROUTE.
- THE CLOSED PORTION OF THE MAIN ROUTE SHALL BE PROTECTED BY b) BLOCKING WITH TYPE III BARRICADES, 1/2 OF THE CROSS SECTION OF THE CLOSED PORTION.
- CONES MAY BE SUBSTITUTED FOR BARRICADES OR DRUMS AT HALF THE SPACING DURING DAY OPERATIONS. CONES SHALL BE A MINIMUM OF 28 (710) IN HEIGHT
- WHEN THE SIDE ROAD LIES BETWEEN THE BEGINNING OF THE MAINL®NE
 4. SIGNING AND THE WORK ZONE, A SINGLE HEADED ARROW (M6-1) SHALL
 BE USED IN LIEU OF THE DOUBLE HEADED ARROW (M6-4).

SCALE: NONE


- WHEN WORK IS BEING PERFORMED ON A SIDE ROAD OR DRIVEWAY, FOLLOW THE APPLICABLE STANDARD(S). THE DIRECTIONAL ARROW (M6-1 OR M6-4) SHALL BE COVERED OR REMOVED WHEN NO LONGER CONSISTENT WITH THE TRAFFIC CONTROL SET-UP.
- 6. ADVANCE WARNING SIGNS ARE TO BE OMITTED ON DRIVEWAYS UNLESS OTHERWISE SPECIFIED IN THE PLANS OR BY THE
- THE TRAFFIC CONTROL AND PROTECTION FOR SIDE ROADS, INTERSECTIONS, AND DRIVEWAYS SHALL BE INCLUDED IN THE COST OF SPECIFIED TRAFFIC CONTROL STANDARDS OR ITEMS.

All dimensions are in inches (millimeters) unless otherwise shown.

STATE OF ILLINOIS DEPARTMENT OF TRANSPORTATION

TRAFFIC CONTROL AND PROTECTION FOR SIDE ROADS, INTERSECTIONS, AND DRIVEWAYS


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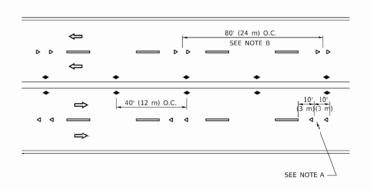
*** REDUCE TO 40' (12 m) O.C. ON CURVES WITH POSTED OR ADVISORY SPEED 45 M.P.H. (70 km/h) OR LESS.

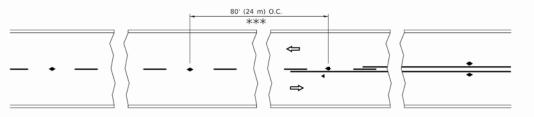
3 @ 40' (12 m) O.C. \Rightarrow LANE REDUCTION TRANSITION

SEE FIGURE 3B-14 MUTCD




TW0-LANE/TW0-WAY

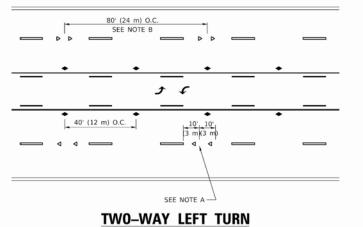


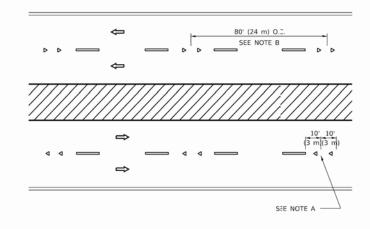

MULTI-LANE/DIVIDED

MULTI-LANE/UNDIVIDED

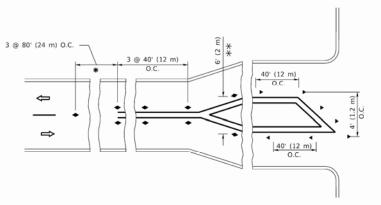

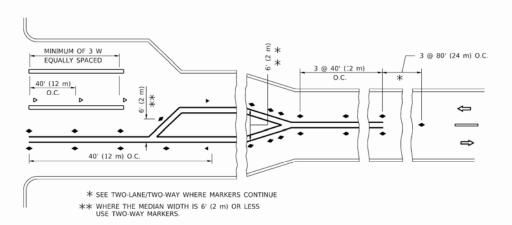

TURN LANES

GENERAL NOTES

- 1. MARKERS USED WITH DASHED LINES SHALL BE
- 2. MARKERS USED ADJACENT TO SOLID LINES SHALL BE OFFSET 2 TO 3 (50 TO 75) TOWARD TRAFFIC AS SHOWN.
- 3. MARKERS THROUGH TANGENTS LESS THAN 500' (150 m) IN LENGTH BETWEEN CURVES SHALL BE INSTALLED AT THE LESSER OF THE TWO CURVE SPACINGS.
- 4. MARKERS ARE TO BE USED ADJACENT TO BOTH SOLID WHITE LINES IN DUAL LEFT TURN LANES

LANE MARKER NOTES

- A. USE DOUBLE LANE LINE MARKERS SPACED AS SHOWN.
- B. REDUCE TO 40' (12 m) O.C. ON CURVES WHERE ADVISORY SPEEDS ARE 10 M.P.H (20 km/h) LOWER THAN POSTED SPEEDS.

DESIGN NOTES

- 1. DOUBLE LANE LINE MARKERS SHALL BE USED UNLESS SPECIFIED OTHERWISE.
- THE PLANS WHEN STANDARD SPECIFICATIONS ARE NOT BEING USED.
- 4. MARKERS SHOULD NOT BE USED ALONGSIDE CURBS EXCEPT FOR EXTREMELY SHORT SECTIONS OF CURBS WHERE NOT MORE THAN TWO MARKERS WOULD BE

All dimensions are in inches (millimeters) unless otherwise shown.

DESIGNED REVISED - T. RAMMACHER 03-12-99 DRAWN REVISED - T. RAMMACHER 01-06-00 CHECKED C. JUCIUS 09-09-09 PLOT DATE = 3/4/2019 DATE REVISED C. JUCIUS 07-01-13

STATE OF ILLINOIS **DEPARTMENT OF TRANSPORTATION**

TYPICAL APPLICATIONS RAISED REFLECTIVE PAVEMENT MARKERS (SNOW-PLOW RESISTANT) SHEET 1 OF 1 SHEETS STA.

COUNTY SECTION 24-00022-00-RS 0098 KANE 18 15 CONTRACT NO. TC-11

SYMBOLS


■ ONE-WAY AMBER MARKER

◆ TWO-WAY AMBER MARKER

◆ ONE-WAY CRYSTAL MARKER (W/O)

YELLOW STRIPE

- 2. EXCEPT AS SHOWN ON THE LANE REDUCTION TRANSITION AND FREEWAY EXIT RAMP DETAIL, MARKERS ARE NOT TO BE SPECIFIED ON RIGHT EDGE LINES.
- 3. THE EXACT MARKER LIMITS, SPACING, AND COLOR SHALL BE INCLUDED IN

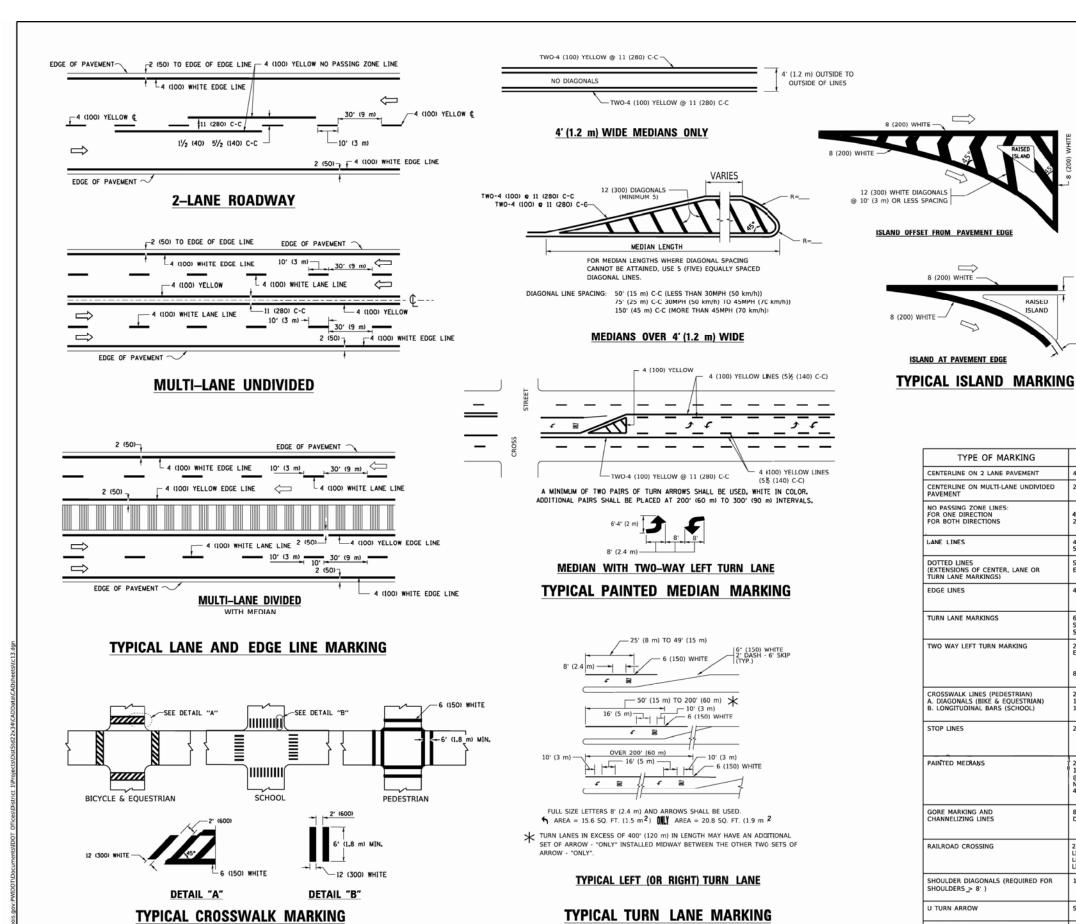

6'-4" (1930) SPEED LIMIT D(FT) 345 30 425 35 500 40 580 45 665 50 750 55 32 R (810) 64 (1620) **COMBINATION** LEFT AND U-TURN 5'-4" (1620) 32 R (810) 20 (510) LANE REDUCTION TRANSITION

* LANE REDUCTION ARROWS REQUIRED AT SPEEDS OF 45 MPH OR

GREATER OR WHEN SPECIFIED IN PLANS.

TYPE OF MARKING WIDTH OF LINE PATTERN COLOR SPACING / REMARKS CENTERLINE ON 2 LANE PAVEMENT 4 (100) SKIP-DASH YELLOW 10' (3 m) LINE WITH 30' (9 m) SPACE CENTERLINE ON MULTI-LANE UNDIVIDED SOLID ELLOW 11 (280) C-C 2 @ 4 (100) PAVEMENT NO PASSING ZONE LINES: FOR ONE DIRECTION FOR BOTH DIRECTIONS 5½ (140) C-C FROM SKIP-DASH CENTERLINE 11 (280) C-C OMIT SKIP-DASH CENTERLINE BETWEEN LANE LINES SKIP-DASH SKIP-DASH 4 (100) 5 (125) ON FREEWAYS DOTTED LINES (EXTENSIONS OF CENTER, LANE OR TURN LANE MARKINGS) SAME AS LINE BEING EXTENDED SKIP-DASH SAME AS LINE BEING EXTENDED 2' (600) LINE WITH 6' (1.8 m) SPACE EDGE LINES 4 (100) SOLID OUTLINE MEDIANS IN YELLOW WHITE-RIGH TURN LANE MARKINGS 6 (150) LINE; FULL SIZE LETTERS & SOLID WHITE SEE TYPICAL TURN LANE MARKING DETAIL SYMBOLS (8' (2.4m)) 10' (3 m) LINE WITH 30' (9 m) SPACE FOR SKIP-DASH; 5½ (140) C-C BETWEEN SOLID TWO WAY LEFT TURN MARKING SKIP-DASH AND SOLID YELLOW 2 @ 4 (100) EACH DIRECTION LINE AND SKIP-DASH LINE SEE TYPICAL TWO-WAY LEFT TURN MARKING DETAIL B' (2.4m) LEFT ARROW WHITE CROSSWALK LINES (PEDESTRIAN) A. DIAGONALS (BIKE & EQUESTRIAN) B. LONGITUDINAL BARS (SCHOOL) NOT LESS THAN 6' (1.8 m) APART 2' (600) APART SOLID SOLID SOLID WHITE WHITE WHITE 12 (300) @ 45° 12 (300) @ 90° 2' (600) APART SEE TYPICAL CROSSWALK MARKING DETAILS. PLACE 4' (1.2 m) IN ADVANCE OF AND PARALLEL TO CROSSWALK, IF PRESENT. OTHERWISE, PLACE AT DESIRED STOPPING POINT. PARALLEL TO CROSSROAD CENTERLINE, WHERE POSSIBLE STOP LINES 24 (600) SOLID WHITE 2 @ 4 (100) WITH 12 (300) DIAGONALS @ 45° NO DIAGONALS USED FOR 4' (1.2 m) WIDE MEDIANS 11 (280) C-C FOR THE DOUBLE LINE SEE TYPICAL PAINTED MEDIAN MARKING. PAINTED MEDIANS SOLID TWO WAY TRAFFIC WHITE: ONE WAY TRAFFIC 8 (200) WITH 12 (300) DIAGONALS @ 45* DIAGONALS: 15' (4.5 m) C-C (LESS THAN 30MPH (50 km/h)) 20' (6 m) C-C 30MPH (50 km/h) TO 45MPH (70 km/h)) 30' (9 m) C-C (OVER 45MPH (70 km/h)) GORE MARKING AND CHANNELIZING LINES SOLID WHITE SEE STATE STANDARD 780001 AREA OF: "R"=3.6 SQ. FT. (0.33 m) EACH "X"=54.0 SQ. FT. (5.0 m) 2 24 (600) TRANSVERSE LINES; "RR" IS 6' (1.8 m) LETTERS; 16 (400) LINE FOR "X" RAILROAD CROSSING SOLID WHITE 50° (15 m) C-C (LESS THAN 30MPH (50 km/h)) 75° (25 m) C-C (30 MPH (50 km/h) TO 45MPH (70 km/h)) 150° (45 m) C-C (OVER 45MPH (70 km/h)) SOLID WHITE - RIGHT YELLOW - LEFT SHOULDER DIAGONALS (REQUIRED FOR 12 (300) @ 45° SHOULDERS > 8') SOLID 2 ARROW COMBINATION SEE DETAIL SOLID WHITE LEFT AND U TURN

12 (300)

U-TURN

FOR FURTHER DETAILS ON PAVEMENT MARKING REFER TO STANDARD SPECIFICATIONS FOR ROAD AND BRIDGE CONSTRUCTION AND STATE STANDARD 780001.

8 (200) WHITE

ISLAND AT PAVEMENT EDGE

- 2 (50)

2 (50)

RAISED

ISLAND


All dimensions are in inches (millimeters)


USER NAME = footemj	DESIGNED - EVERS	REVISED	-	C. JUCIUS 09-09-09
	DRAWN -	REVISED	-	C. JUCIUS 07-01-13
PLOT SCALE = 50.0000 * / in.	CHECKED -	REVISED	-	C. JUCIUS 12-21-15
PLOT DATE = 3/4/2019	DATE - 03-19-90	REVISED	-	C. JUCIUS 04-12-16

* MARKINGS SHALL BE INSTALLED PARALLEL TO THE CENTERLINE OF THE ROAD WHICH IT CROSSES

STATE OF ILLINOIS **DEPARTMENT OF TRANSPORTATION**


	F.A.U. RTE.	SECTION	COUNTY	TOTAL SHEETS	SHEET NO.	
TYPICAL PAVEMENT MARKINGS	0098	24-00022-00-RS	KANE	18	16	
TITIOAL PAVENIENT MANKINGS		TC-13	CONTRACT NO.			
SHEET 1 OF 2 SHEETS STA. TO STA.		TILINOIS FED AT	D PROJECT			

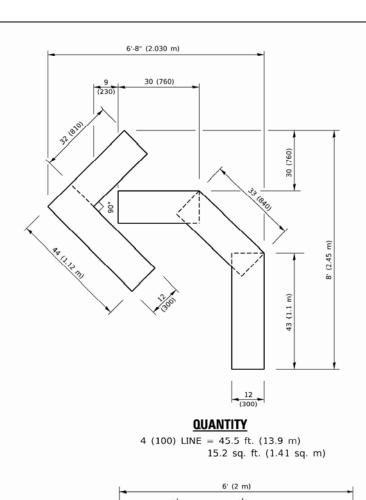

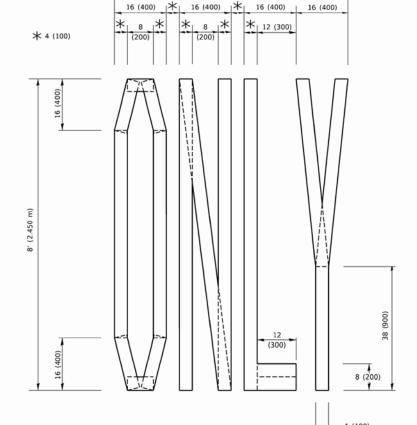

QUANTITY

4 (100) LINE = 64.1 ft. (19.5 m)
21.4 sq. ft. (1.99 sq. m)

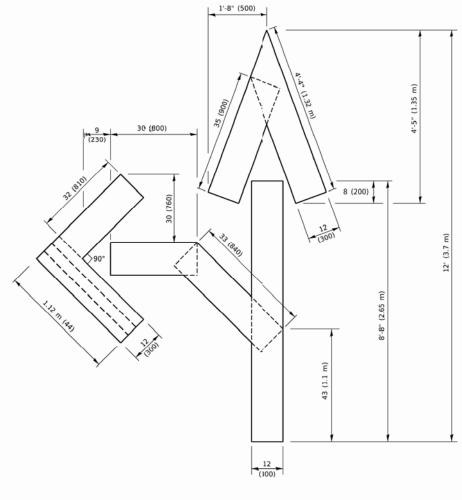


QUANTITY

4 (100) LINE = 82.5 ft. (25.1 m) 27.5 sq. ft. (2.53 sq. m)

NOTE:

ALL QUANTITIES OF PLACEMENT ARE REPRESENTED IN LINEAR FEET OF 4" LINES TO MATCH THE 4" TEMPORARY TAPE PAY ITEM AND REPRESENTS THE TOTAL QUANTITY OF 4" TAPE REQUIRED.

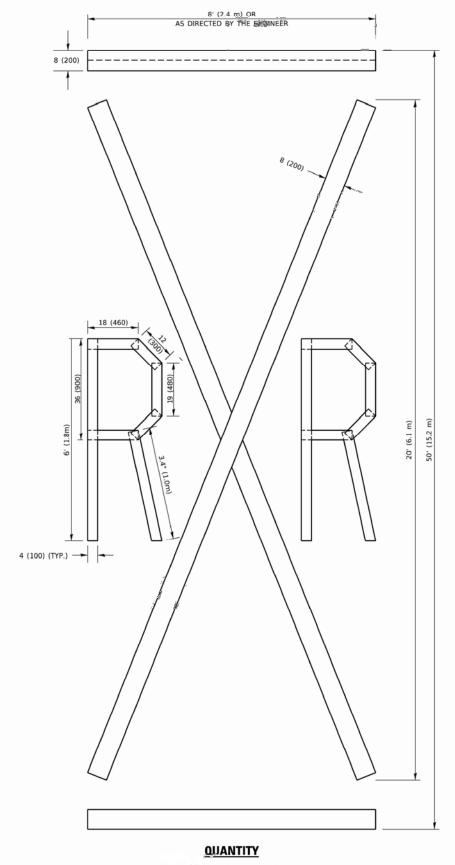

4 (100) LINE = 225.9 ft. (68.9 m) 75.3 sq. ft. (6.99 sq. m)


All dimensions are in inches (millimeters) unless otherwise shown.

USER NAME = footemj	DESIGNED -	REVISED	- T. RAMMACHER 03-02-98
	DRAWN -	REVISED	- E. GOMEZ 08-28-00
PLOT SCALE = 50.0068 ' / in.	CHECKED -	REVISED	- E. GOMEZ 08-28-00
PLOT DATE = 3/4/2019	DATE - 09-18-94	REVISED	- A. SCHUETZE 09-15-16

STATE OF ILLINOIS
DEPARTMENT OF TRANSPORTATION

	SHORT	TERN	1 F	PAV	EMENT	Γ	MARKING	LETTERS	AND	SYMBOLS	
ALE:	NONE	SH	EET	1	OF	1	SHEETS	STA		TO STA	

F.A.U. RTE.	SECT	ПОИ	COUNTY	TOTAL SHEETS	SHEET NO.	
0098	24-0002	2-00-RS	KANE	17		
	TC-16		CONTRACT NO.			
		ILLINOIS	ID PROJECT			

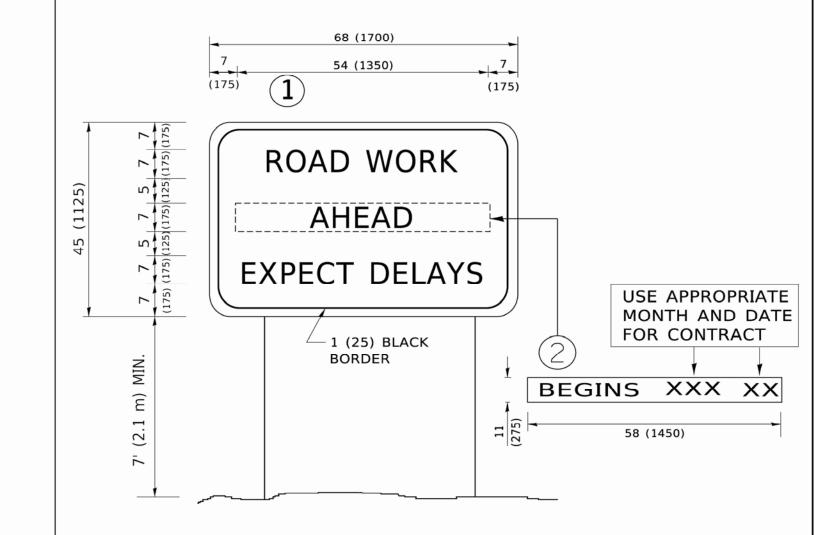

NOTES:

- 1. USE BLACK LETTERING ON ORANGE BACKGROUND.
- 2. ERECT SIGNS IN ADVANCE OF THE LOCATION FOR THE "ROAD CONSTRUCTION AHEAD" SIGN AT LOCATIONS AS DIRECTED BY THE ENGINEER.
- 3. ERECT SIGN(1)WITH INSTALLED PANEL(2)ONE WEEK PRIOR TO THE START OF CONSTRUCTION.
- 4. REMOVE PANEL(2)SOON AFTER THE START OF CONSTRUCTION.
- 5. SEE SPECIAL PROVISION FOR "TEMPORARY INFORMATION SIGNING" FOR ADDITIONAL INFORMATION.
- 6. ONE SIGN ASSEMBLY EQUALS 25.70 SQ. FT. (2.3 SQ. M.)

SCALE: NONE

7. SHALL BE PAID FOR AS TEMPORARY INFORMATION SIGNING.

ALL DIMENSIONS ARE IN INCHES (MILLIMETERS) UNLESS OTHERWISE SHOWN.

USER NAME = footemj	DESIGNED -	REVISED	-	R. MIRS 09-15-97
	DRAWN -	REVISED	-	R. MIRS 12-11-97
PLOT SCALE = 50.0000 ' / in.	CHECKED -	REVISED	- T.	RAMMACHER 02-02-99
PLOT DATE = 3/4/2019	DATE -	REVISED	-	C. JUCIUS 01-31-07

ARTERIAL ROAD								
INFORMATION SIGN								
	SHEET	1	OF	1	SHEETS	STA.	J	

TE.	SECT	TION	COUNTY	SHEETS	NO.			
098	24-0002	2-00-RS	KANE 18		18			
TC-22				CONTRACT NO.				
		ILLINOIS	FFD. A	ND PROJECT				